


\*\*THIS HOME PLAN AND DESIGN IS THE PROPERTY OF CHARLES M. FRUSTERIO AND


Later String OC String

QUESTIONS ON THIS PLAN 866-225-8111

CONSTRUCTION LICENSE FOR BLUEPRINTS READ PRIOR TO CONSTRUCTION

JOB # 3734-2797-0723

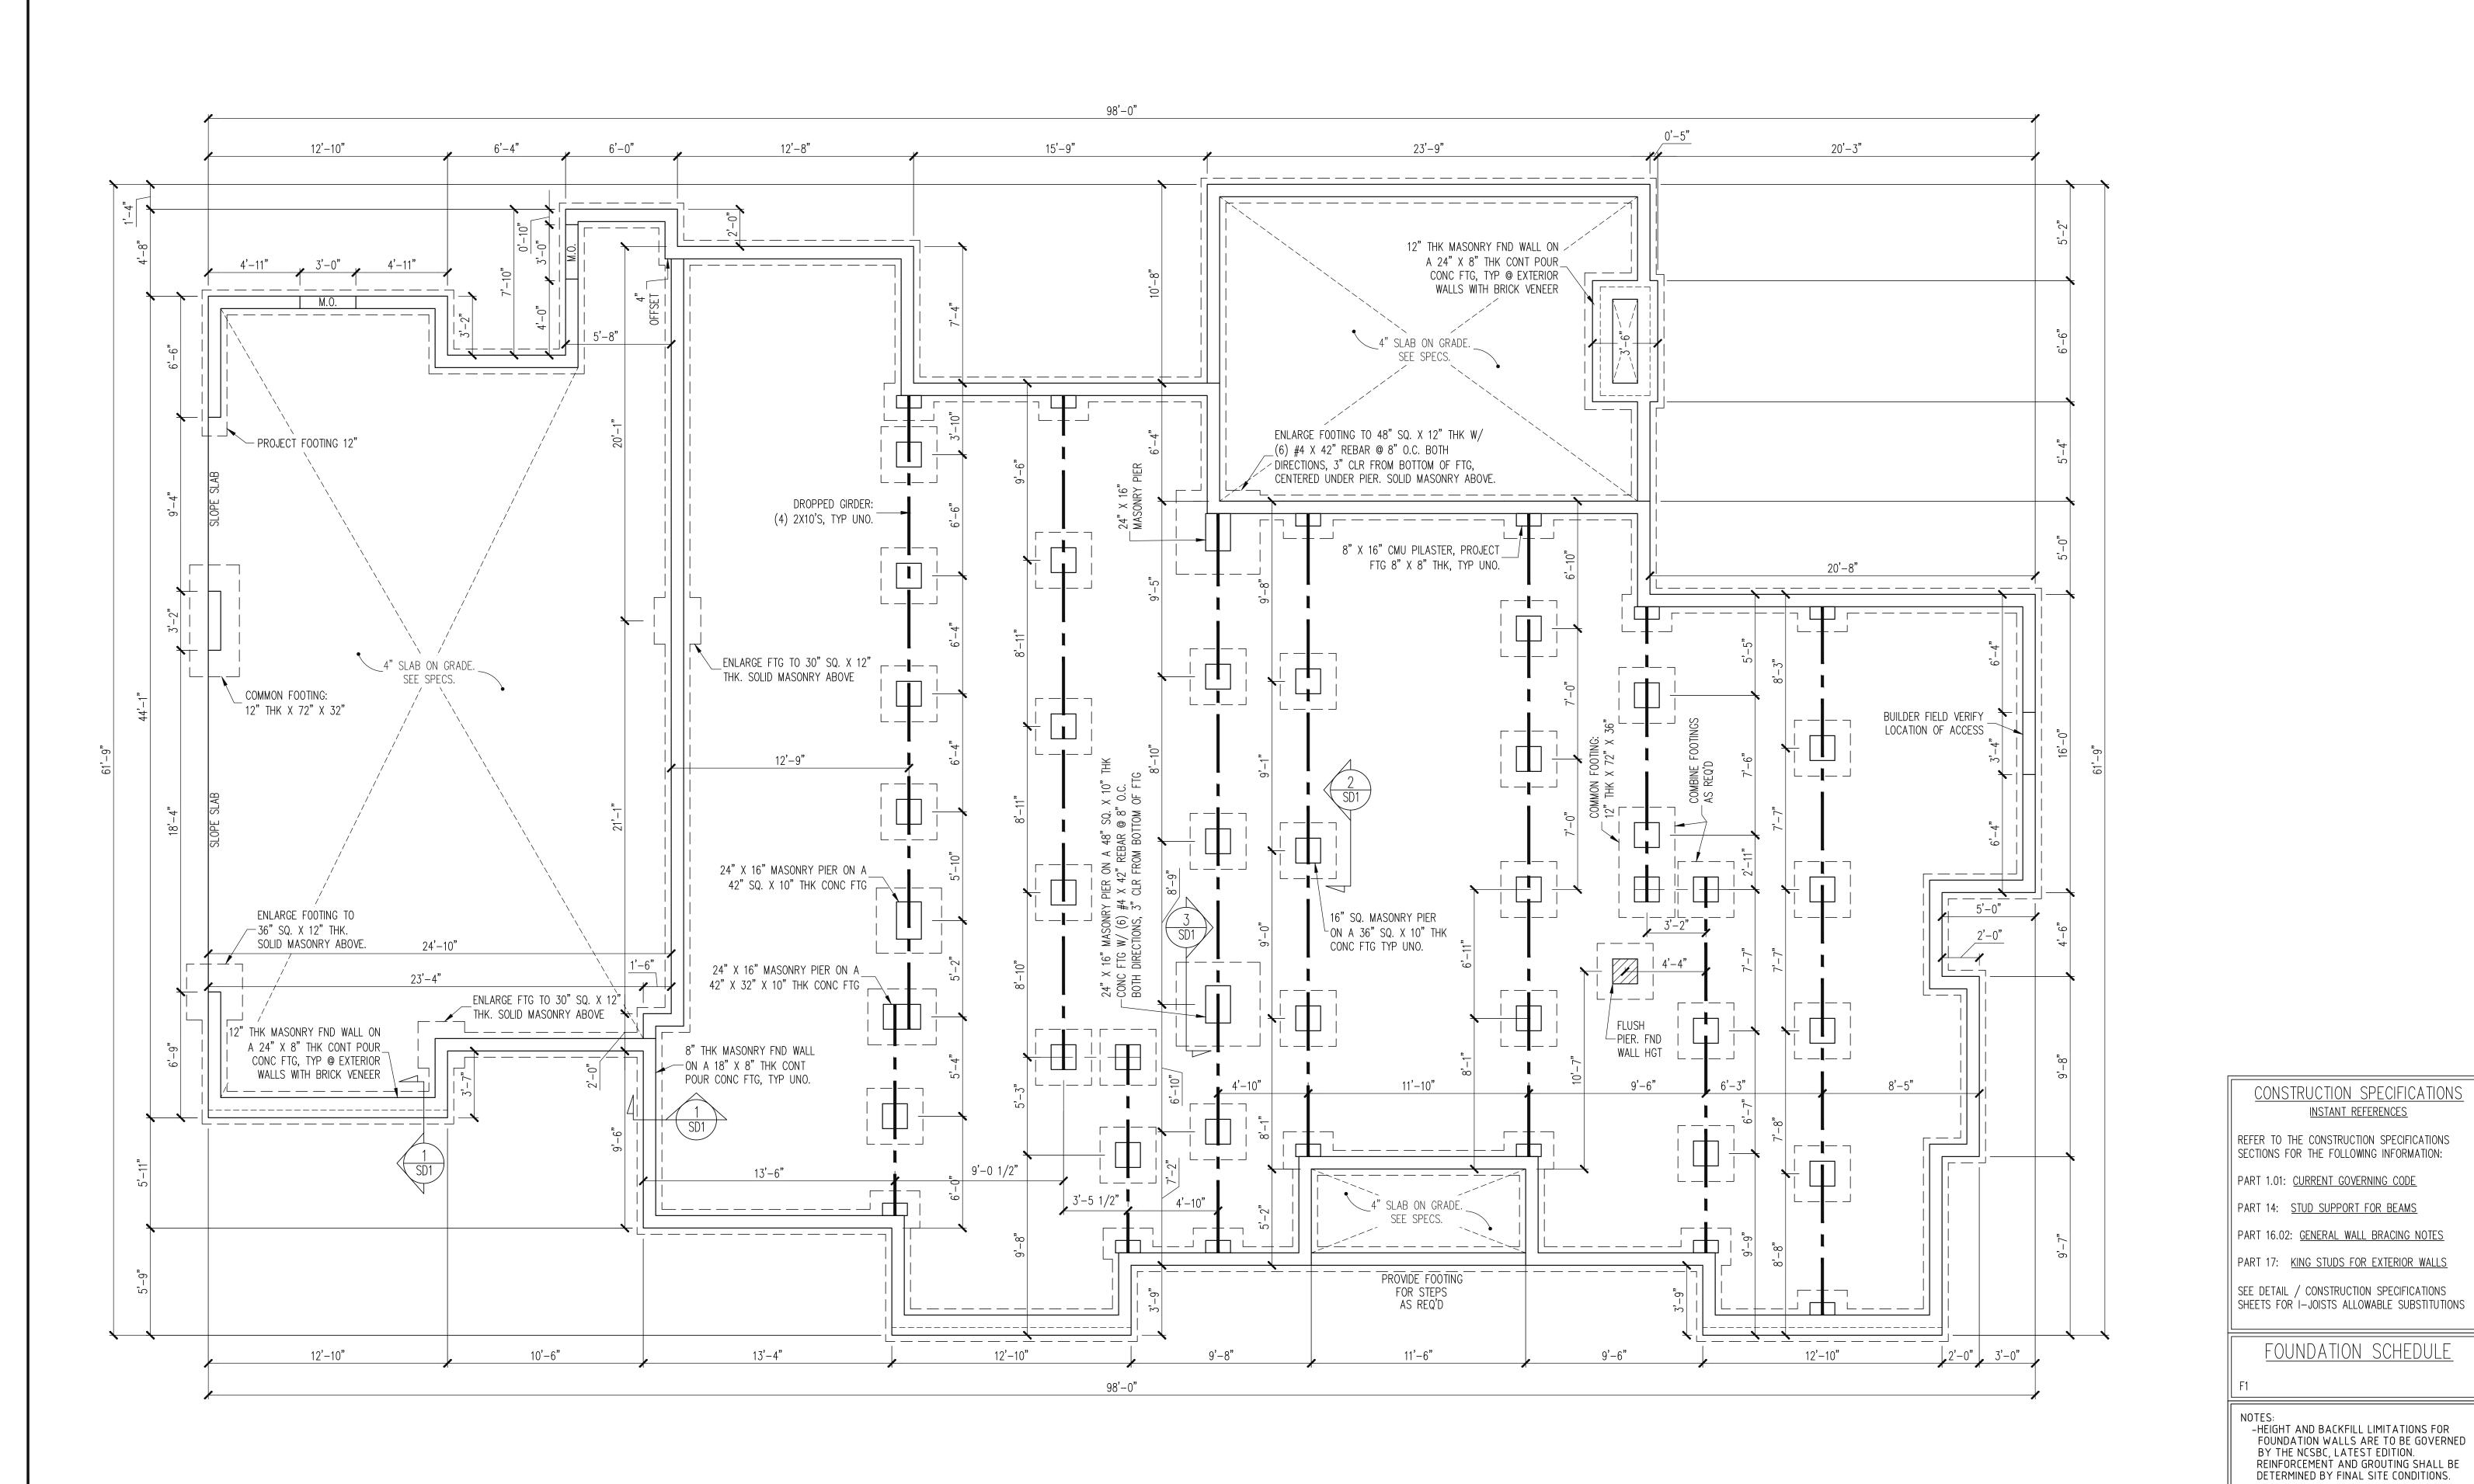

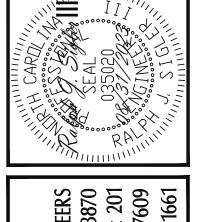

ENG: CIB/RJS DATE: 08/31/2023

PROJECT NO. 23-17-018

SHEET NO.

of 6

FOUNDATION PLAN


INSTANT REFERENCES

-BUILDER TO FIELD LOCATE CRAWLSPACE

ENGINEER APPROVAL.

ACCESS OPENING WITH MINIMUM DIMENSIONS OF 18X24. DO NOT LOCATE ACCESS OPENING BELOW POINT LOADS FROM ABOVE WITHOUT

1/4" = 1'-0"

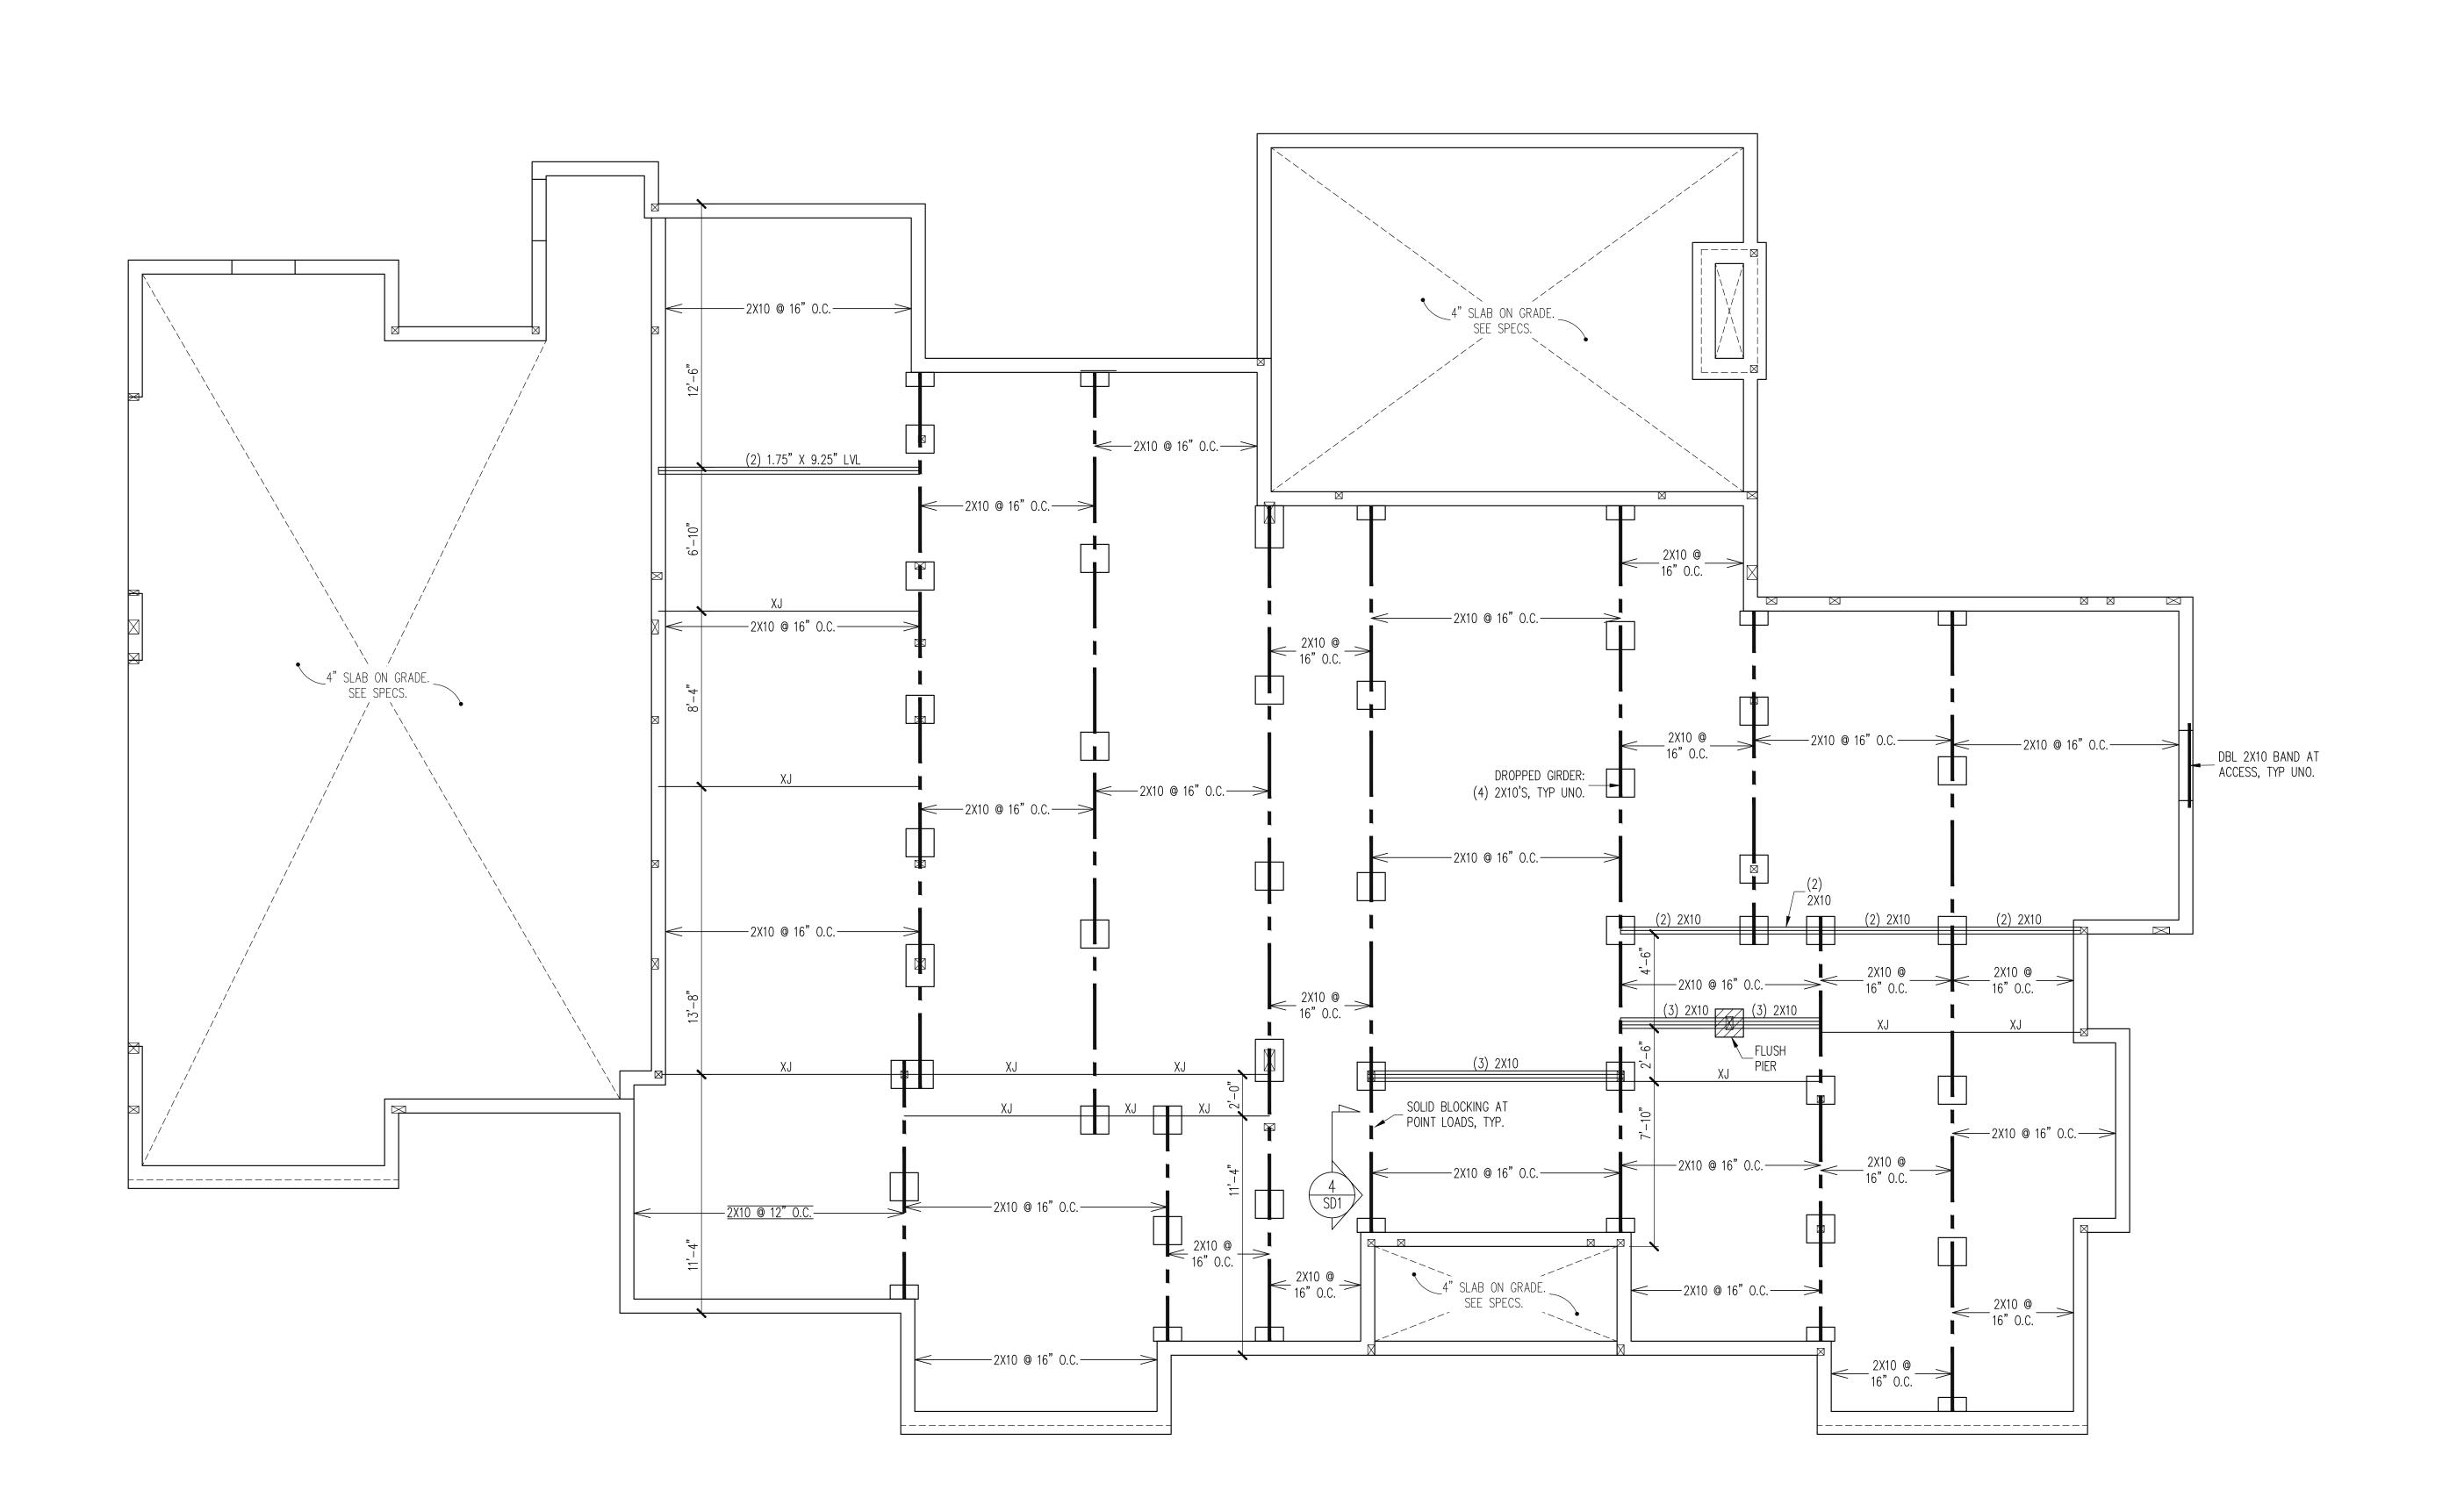


ENG: CIB/RJS


DATE: 08/31/2023

PROJECT NO. 23-17-018

> SHEET NO. 2 of 6

CRAWLSPACE FRAMING PLAN 1/4" = 1'-0"

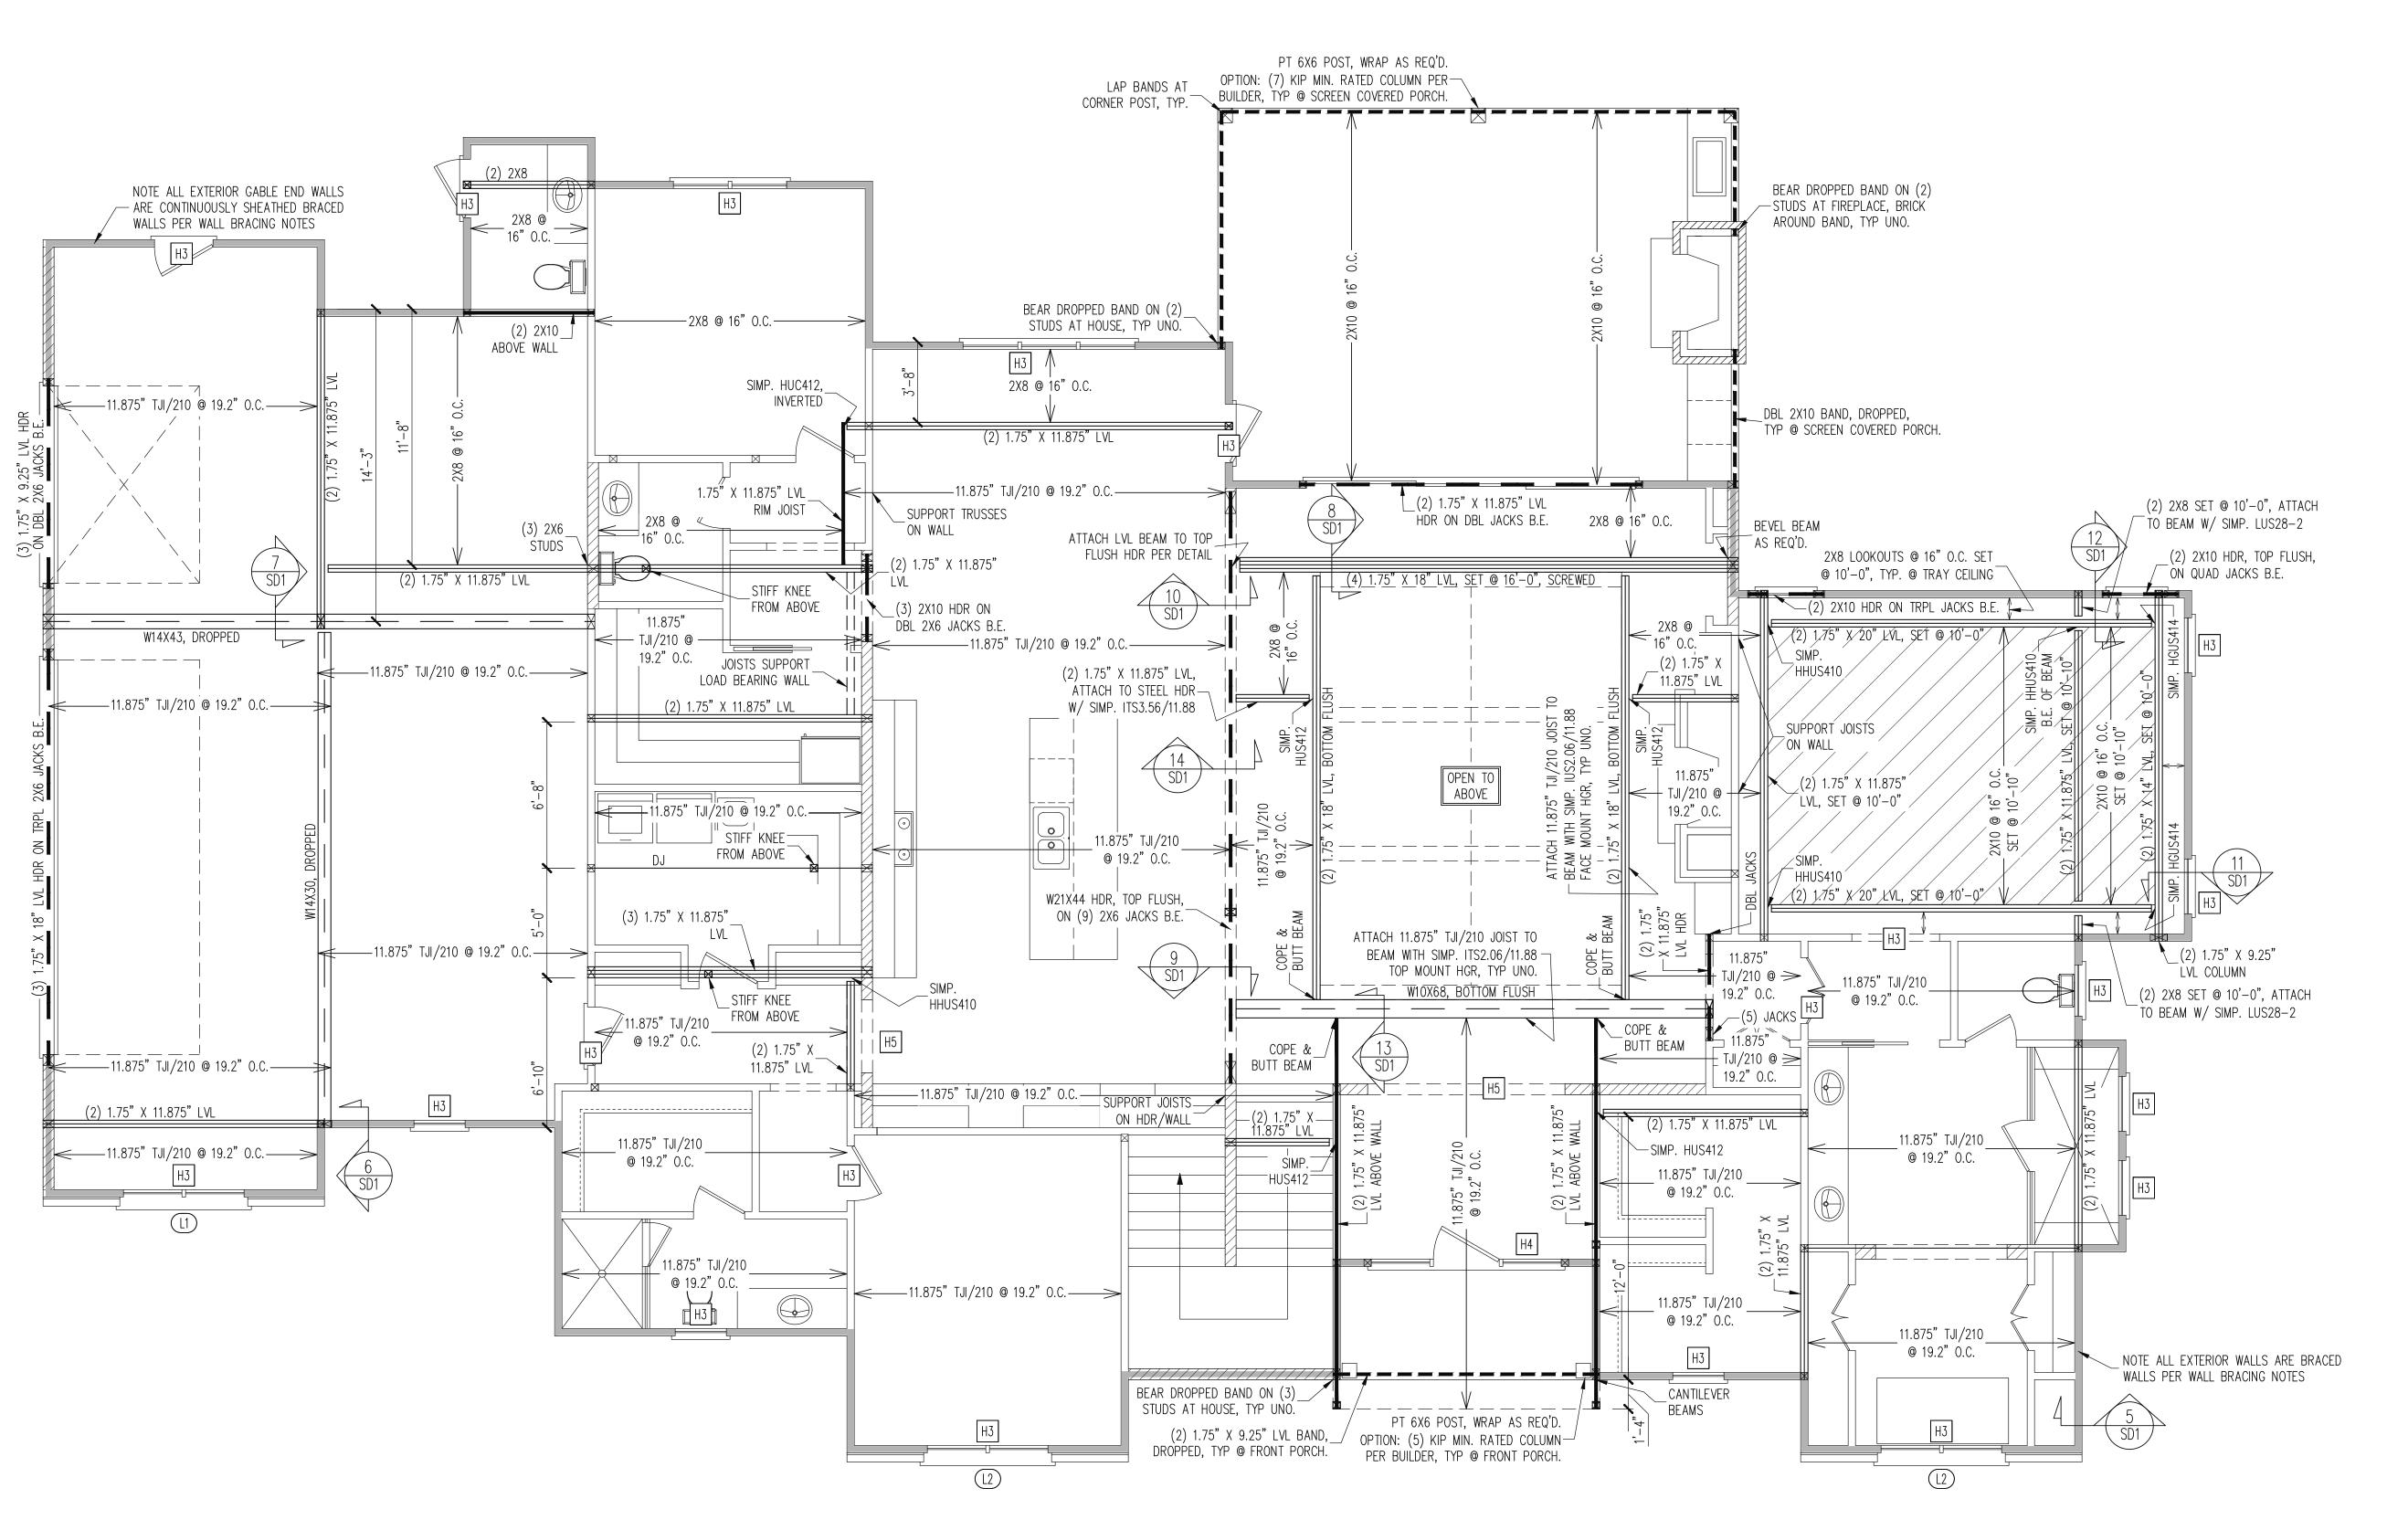

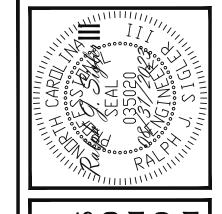

WALL BRACING

ALL EXTERIOR STUD WALLS, EXTERIOR SIDE,

ARE TO BE CONTINUOUSLY SHEATHED WITH

7/16 APA RATED OSB NAILED TO STUDS WITH 8d NAILS @ 6" O.C. AT PANEL EDGES, 12" O.C.

PROVIDED CONTINUOUS SHEATHING = 350' MIN.

REFERENCE PART 16.02 OF CONSTRUCTION

SPECIFICATIONS FOR GENERAL WIND BRACING

## LINTEL SCHEDULE

- L1 L 3 1/2 X 3 1/2 X 1/4 TYP UNO
- L2 L 5 X 3 1/2 X 5/16

SHADED WALLS:

IN PANEL FIELD.

INFORMATION.

- | L3 L 6 X 4 X 5/16 ATTACHED TO HEADER WITH (2) 1/2" X 3" LAG SCREWS @ 16" O.C.
- L4 16 GAGE STEEL FLEX LINTEL AT ARCH

## HEADER SCHEDULE

- H1 SINGLE 2X4 TURNED FLAT (A)
- H2 (2) 2X4'S ON SINGLE JACKS (B)
- H3 (2) 2X10'S ON SINGLE JACKS (C)
- H4 (2) 1.75" X 9.25" LVL'S ON DBL JACKS
- H5 (3) 2X10'S ON SINGLE JACKS
- (A) TYPICAL FOR INTERIOR NON LOAD BEARING WALLS ONLY, ROUGH OPENING 38" MAX.
- (B) TYPICAL FOR INTERIOR NON LOAD BEARING WALLS ONLY, ROUGH OPNG 38" TO 74" MAX.

\_\_\_\_\_

(C) TYPICAL FOR ALL CONDITIONS NOT LISTED IN (A) OR (B) UNO.

-HEADERS IN NON LOAD BEARING INTERIOR

WALLS ARE NOT LABELED. 1ST FLOOR FRAMING PLAN

WALLS AND CEILING 1/4" = 1'-0"

3 of 6

ENG: CIB/RJS


DATE: 08/31/2023


PROJECT NO.

23-17-018

SHEET NO.

**S**3

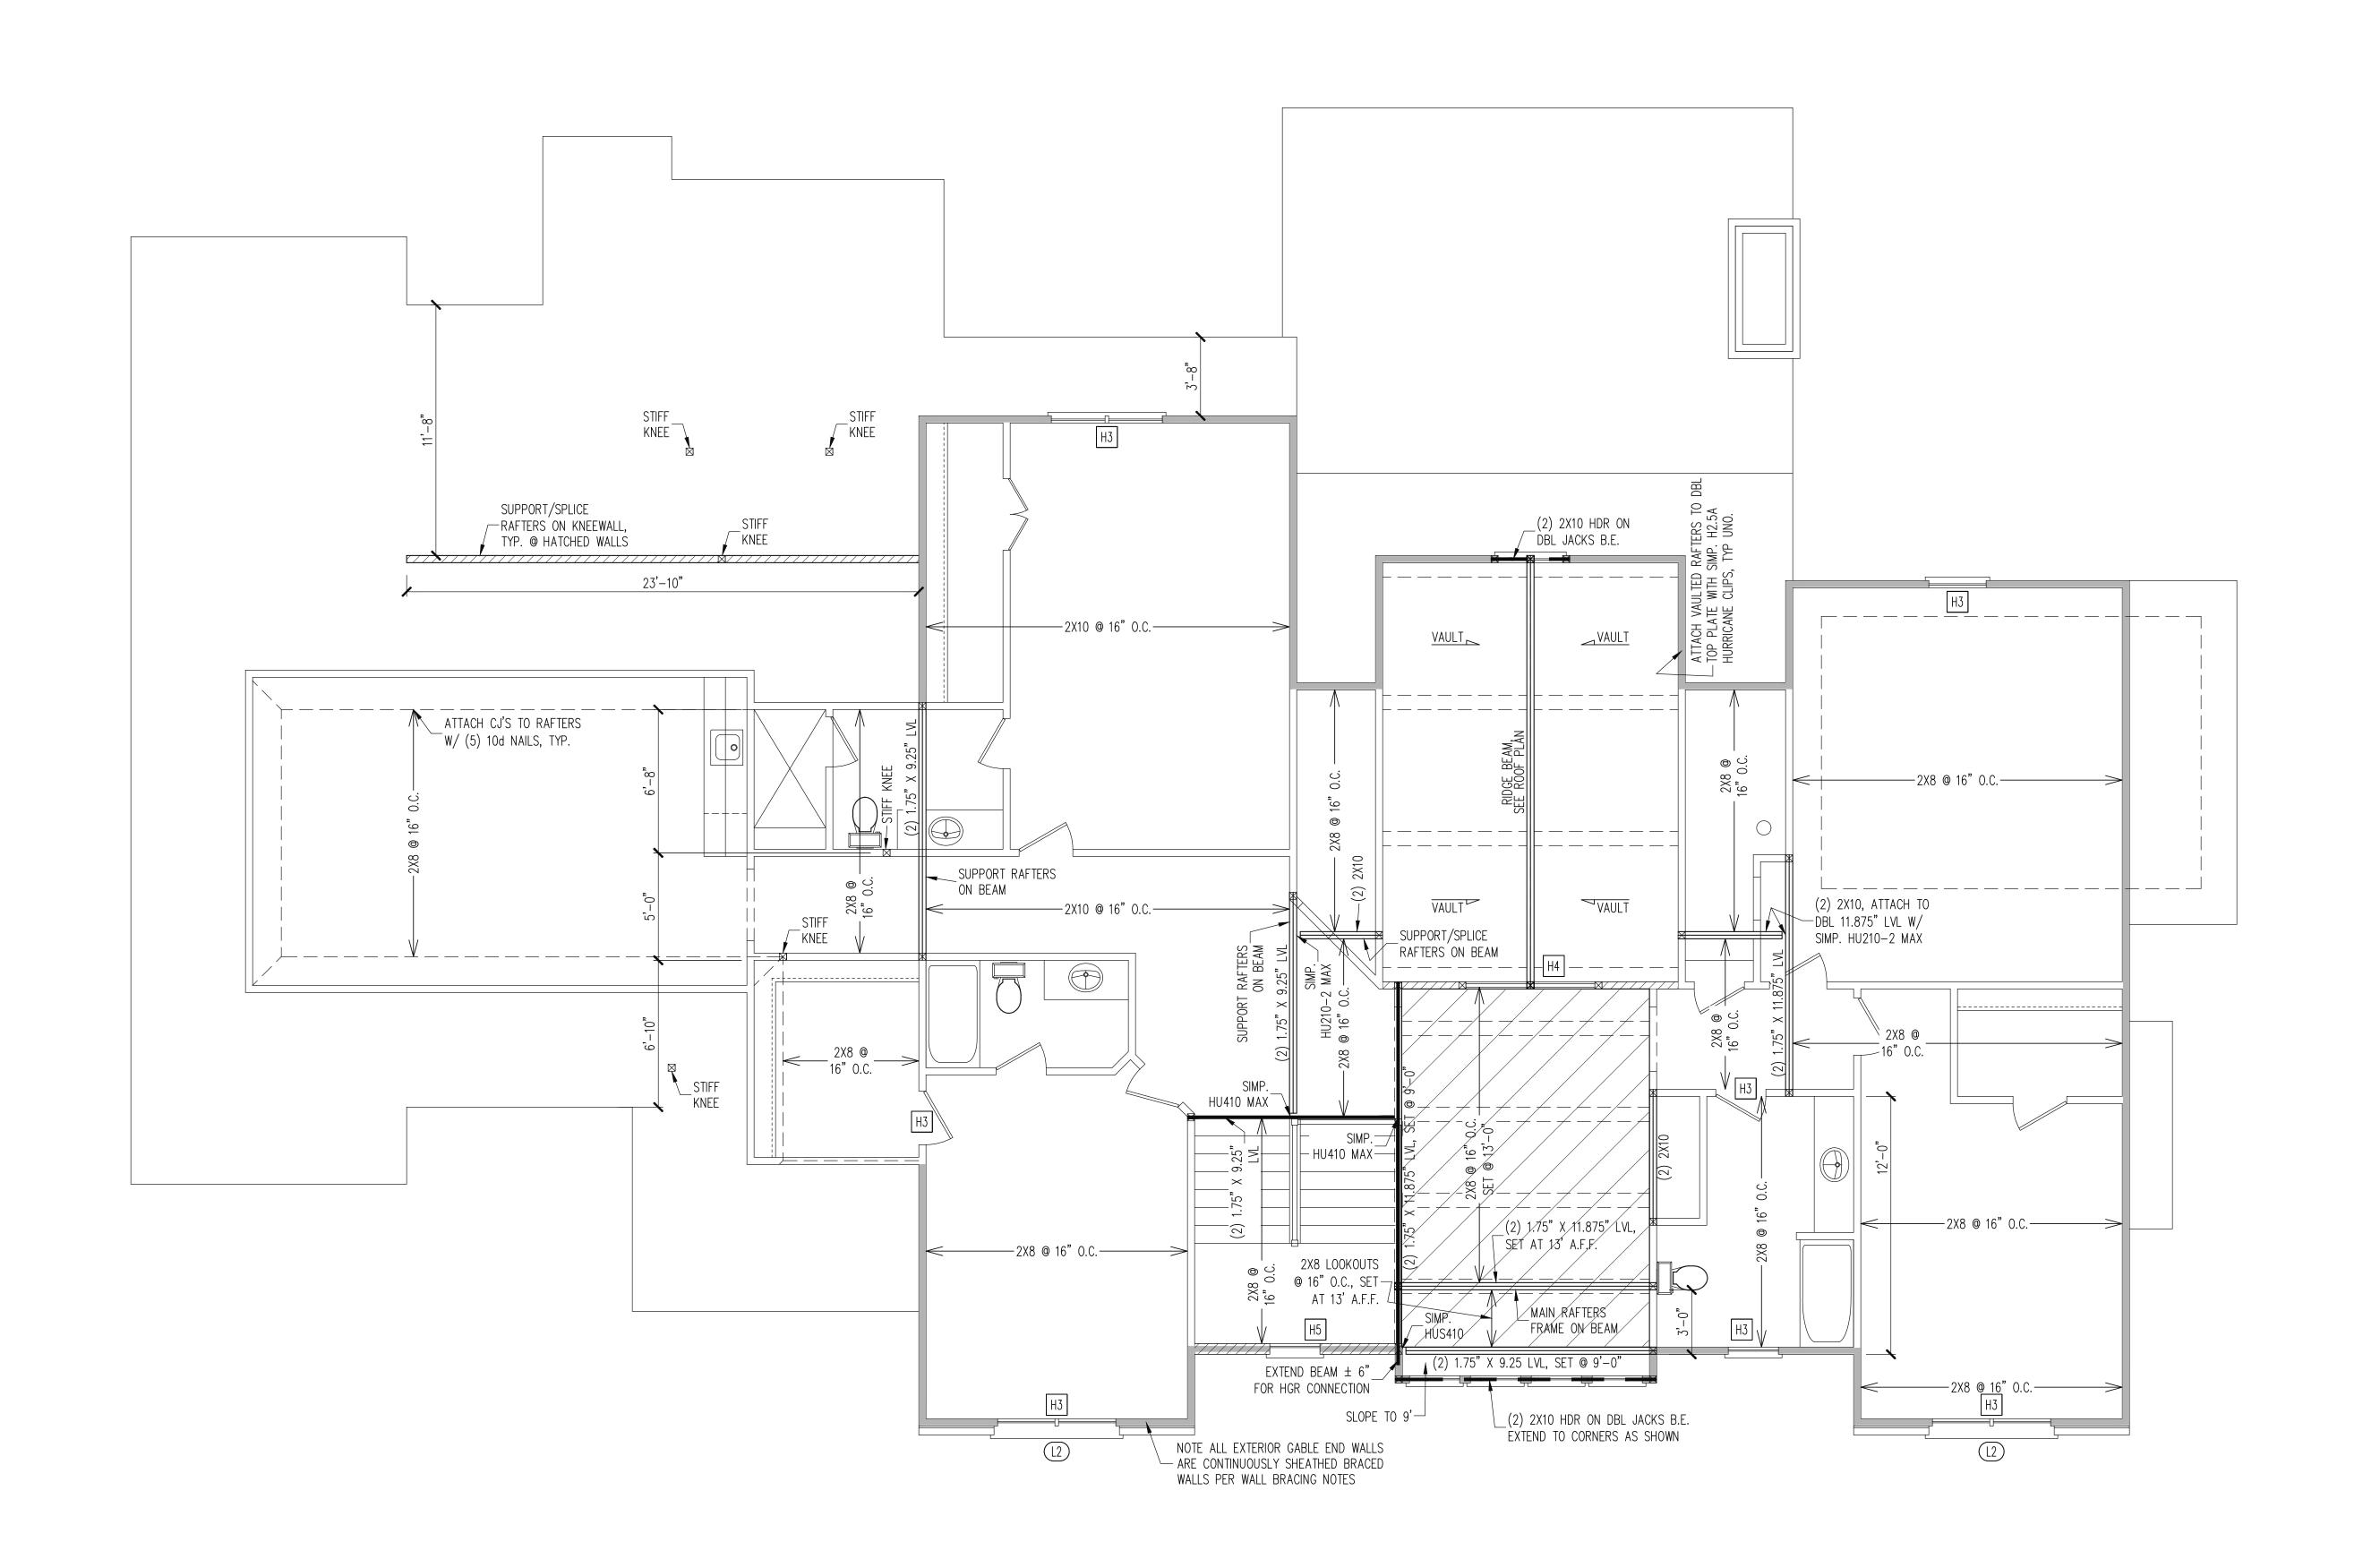

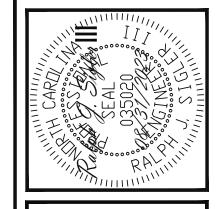

ENG: CIB/RJS

DATE: 08/31/2023

PROJECT NO.

23-17-018

SHEET NO.

ALL EXTERIOR STUD WALLS, EXTERIOR SIDE, ARE TO BE CONTINUOUSLY SHEATHED WITH 7/16 APA RATED OSB NAILED TO STUDS WITH 8d NAILS @ 6" O.C. AT PANEL EDGES, 12" O.C.

PROVIDED CONTINUOUS SHEATHING = 216' MIN.

REFERENCE PART 16.02 OF CONSTRUCTION SPECIFICATIONS FOR GENERAL WIND BRACING INFORMATION.

## LINTEL SCHEDULE

-----

- L1 L 3 1/2 X 3 1/2 X 1/4 TYP UNO

SHADED WALLS:

IN PANEL FIELD.

- L3 L 6 X 4 X 5/16 ATTACHED TO HEADER WITH (2) 1/2" X 3" LAG SCREWS @ 16" O.C.
- L4 16 GAGE STEEL FLEX LINTEL AT ARCH

## HEADER SCHEDULE

- H1 SINGLE 2X4 TURNED FLAT (A)
- H2 (2) 2X4'S ON SINGLE JACKS (B)
- | H3 (2) 2X10'S ON SINGLE JACKS (C)
- H4 (2) 1.75" X 9.25" LVL'S ON DBL JACKS
- H5 (3) 2X10'S ON SINGLE JACKS
- (A) TYPICAL FOR INTERIOR NON LOAD BEARING WALLS ONLY, ROUGH OPENING 38" MAX.
- (B) TYPICAL FOR INTERIOR NON LOAD BEARING WALLS ONLY, ROUGH OPNG 38" TO 74" MAX.

-----

(C) TYPICAL FOR ALL CONDITIONS NOT LISTED IN (A) OR (B) UNO.


-HEADERS IN NON LOAD BEARING INTERIOR

WALLS ARE NOT LABELED.

WALLS AND CEILING 1/4" = 1'-0"

2ND FLOOR FRAMING PLAN

4 of 6

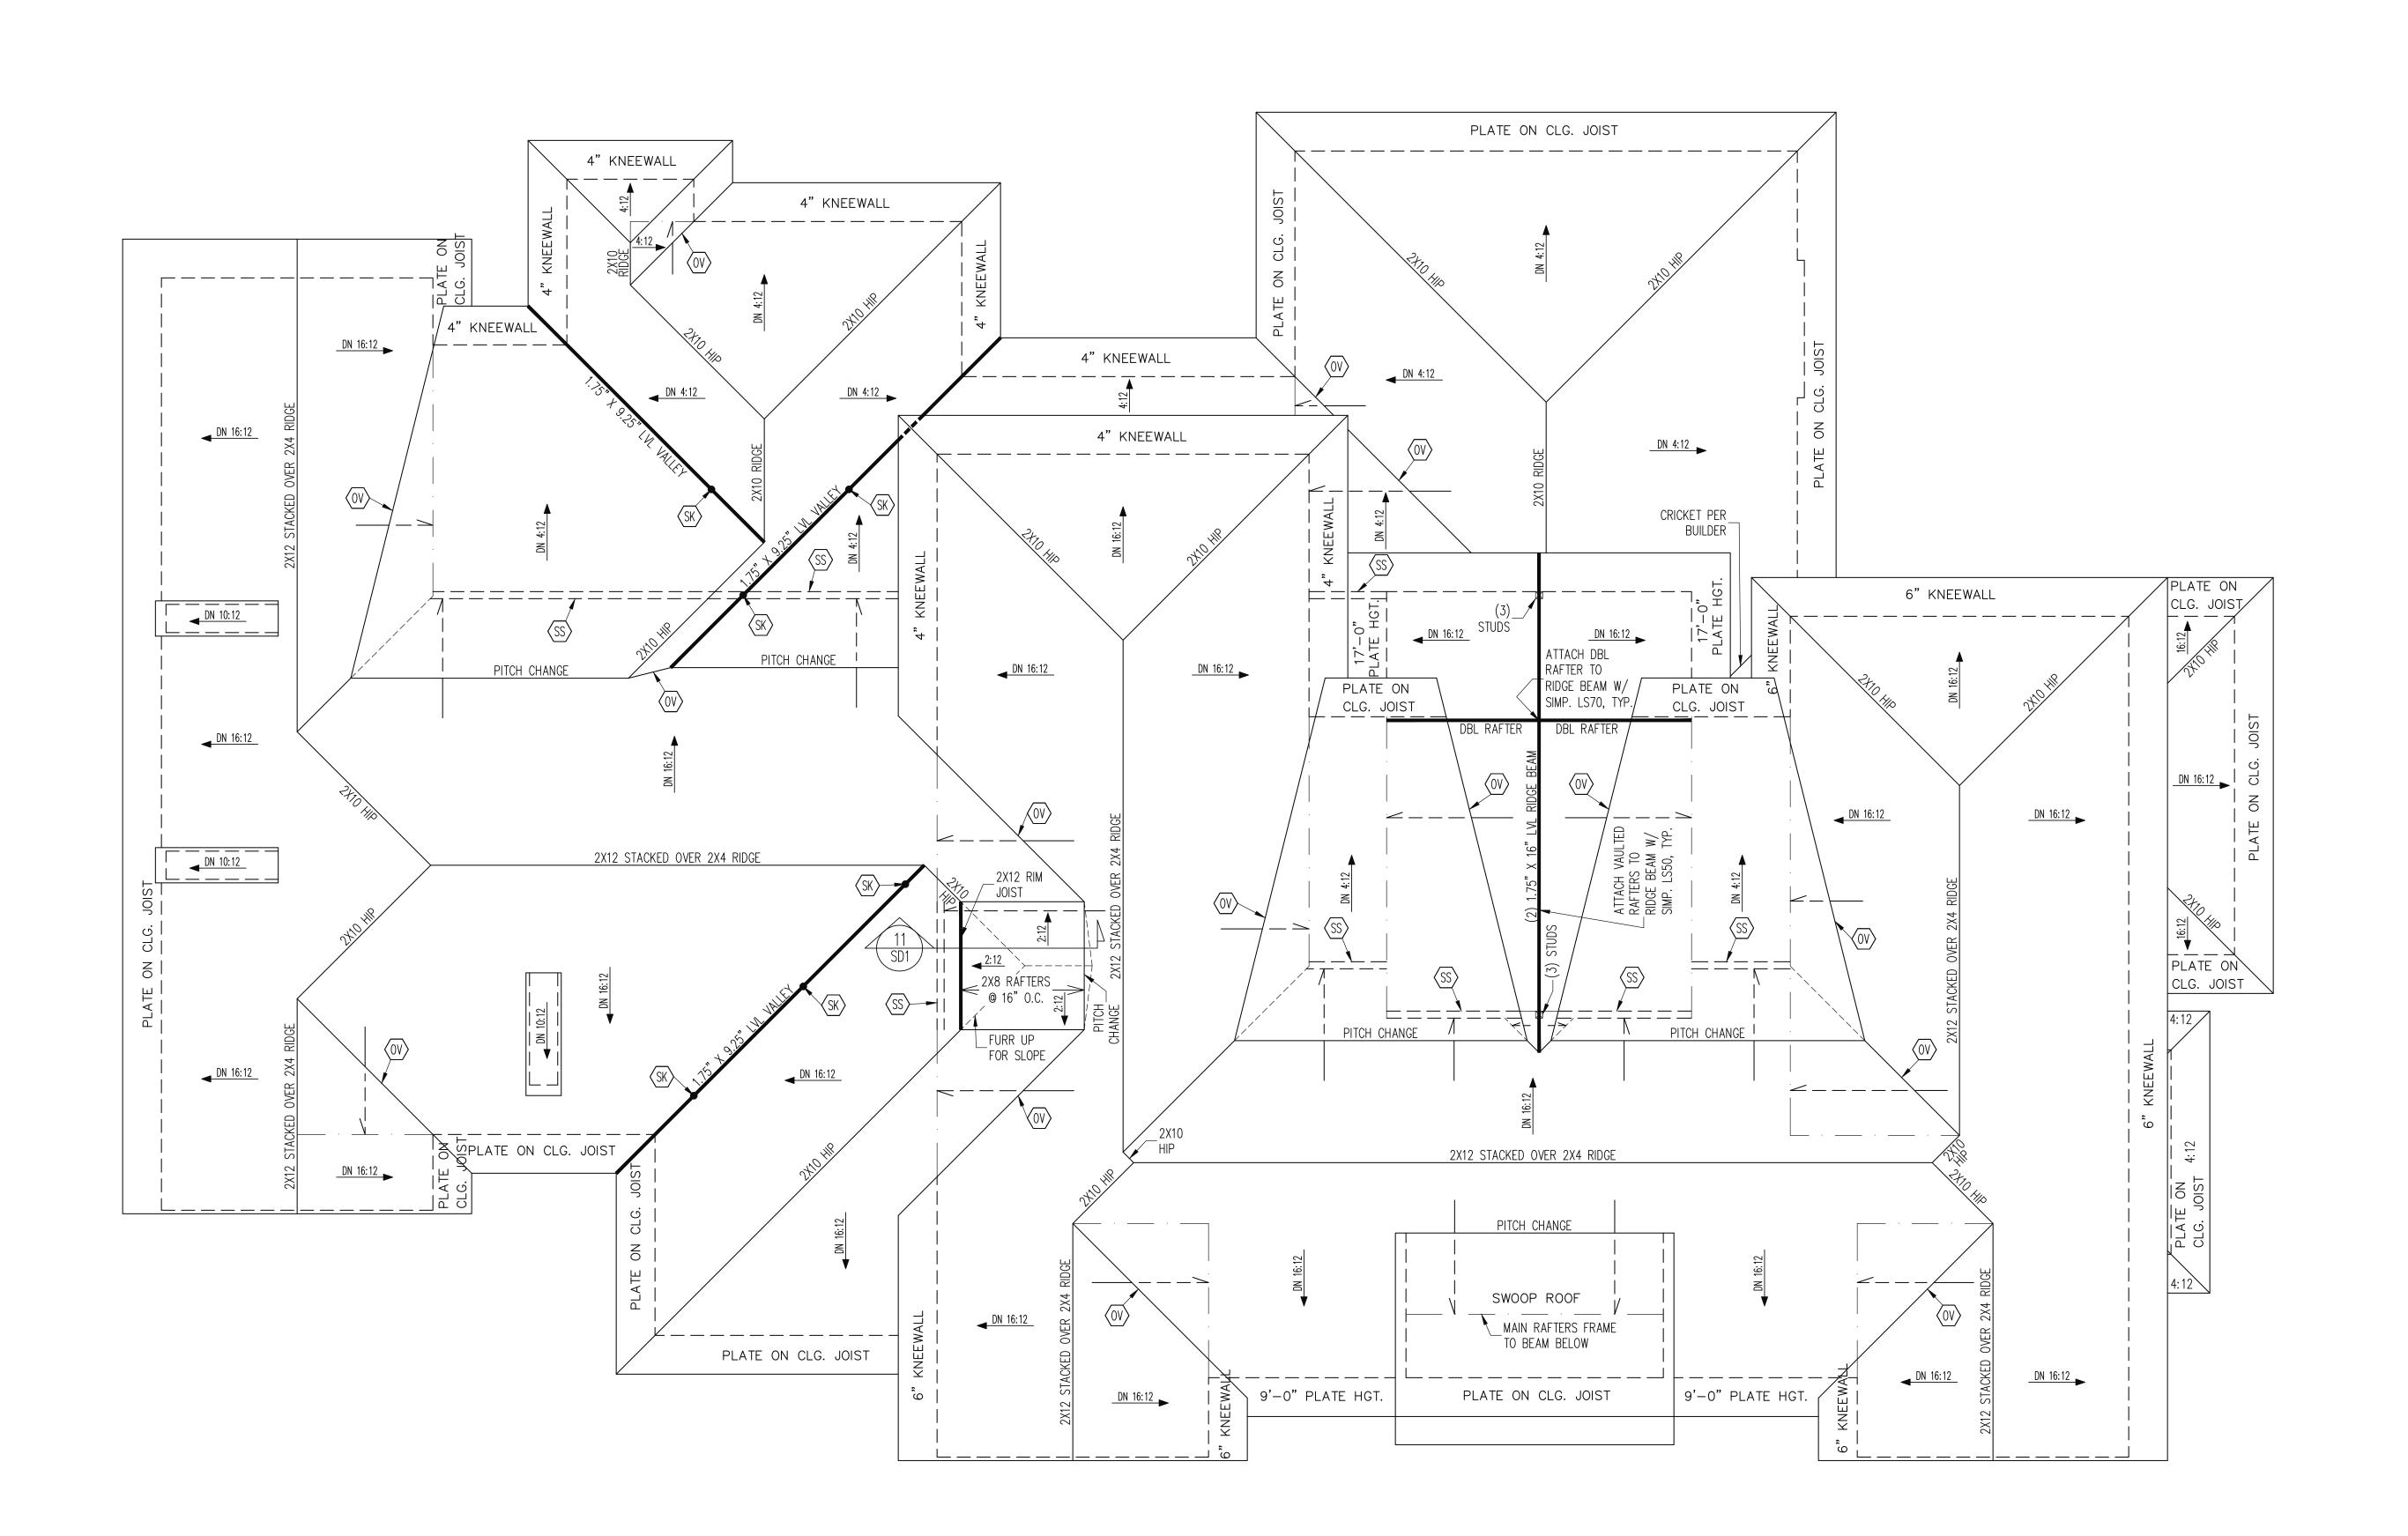

ENG: CIB/RJS DATE: 08/31/2023

PROJECT NO. 23-17-018

> SHEET NO. **S5**

5 of 6

ROOF FRAMING PLAN 1/4" = 1'-0"

FRAMING NOTES

ROOF ONLY

-COMMON RAFTERS 2X8 @ 16" O.C. TYP U.N.O.
-COLLAR TIES 2X4 EVERY 3RD SET OF RAFTERS
TYP U.N.O.
-VERIFY ROOF PITCHES, OVERHANG LENGTHS, AND
KNEEWALL FRAMING HGTS WITH ARCHITECTURAL
DRAWINGS, TYPICAL.

FRAMING SCHEDULE

ROOF ONLY

SB SUPPORT/SPLICE RAFTERS ON BEAM BELOW

SS SUPPORT/SPLICE RAFTERS ON KNEEWALL BELOW

OV OVERFRAME VALLEY ( 2X10 SLEEPER )

SK DBL 2X4 STIFF KNEE

