

PROPOSED
FRONT ELEVATION
SCALE: 1/4"=1'-0"

PROPOSED


REAR ELEVATION

SCALE: 1/4"=1'.0"




NOTE:

ALL DIMENSIONS ARE TO BE VERIFIED BY OWNER/BUILDER BEFORE CONSTRUCTION BEGINS. ONCE CONSTRUCTION HAS BEGUN, DESIGNER IS RELEASED FROM ANY AND ALL LIABILITY ASSOCIATED WITH THE CONSTRUCTION OF THIS CUSTOM RESIDENCE. THIS PLAN IS DESIGNED UNDER THE 2012 NORTH CAROLINA RESIDENTIAL CODE

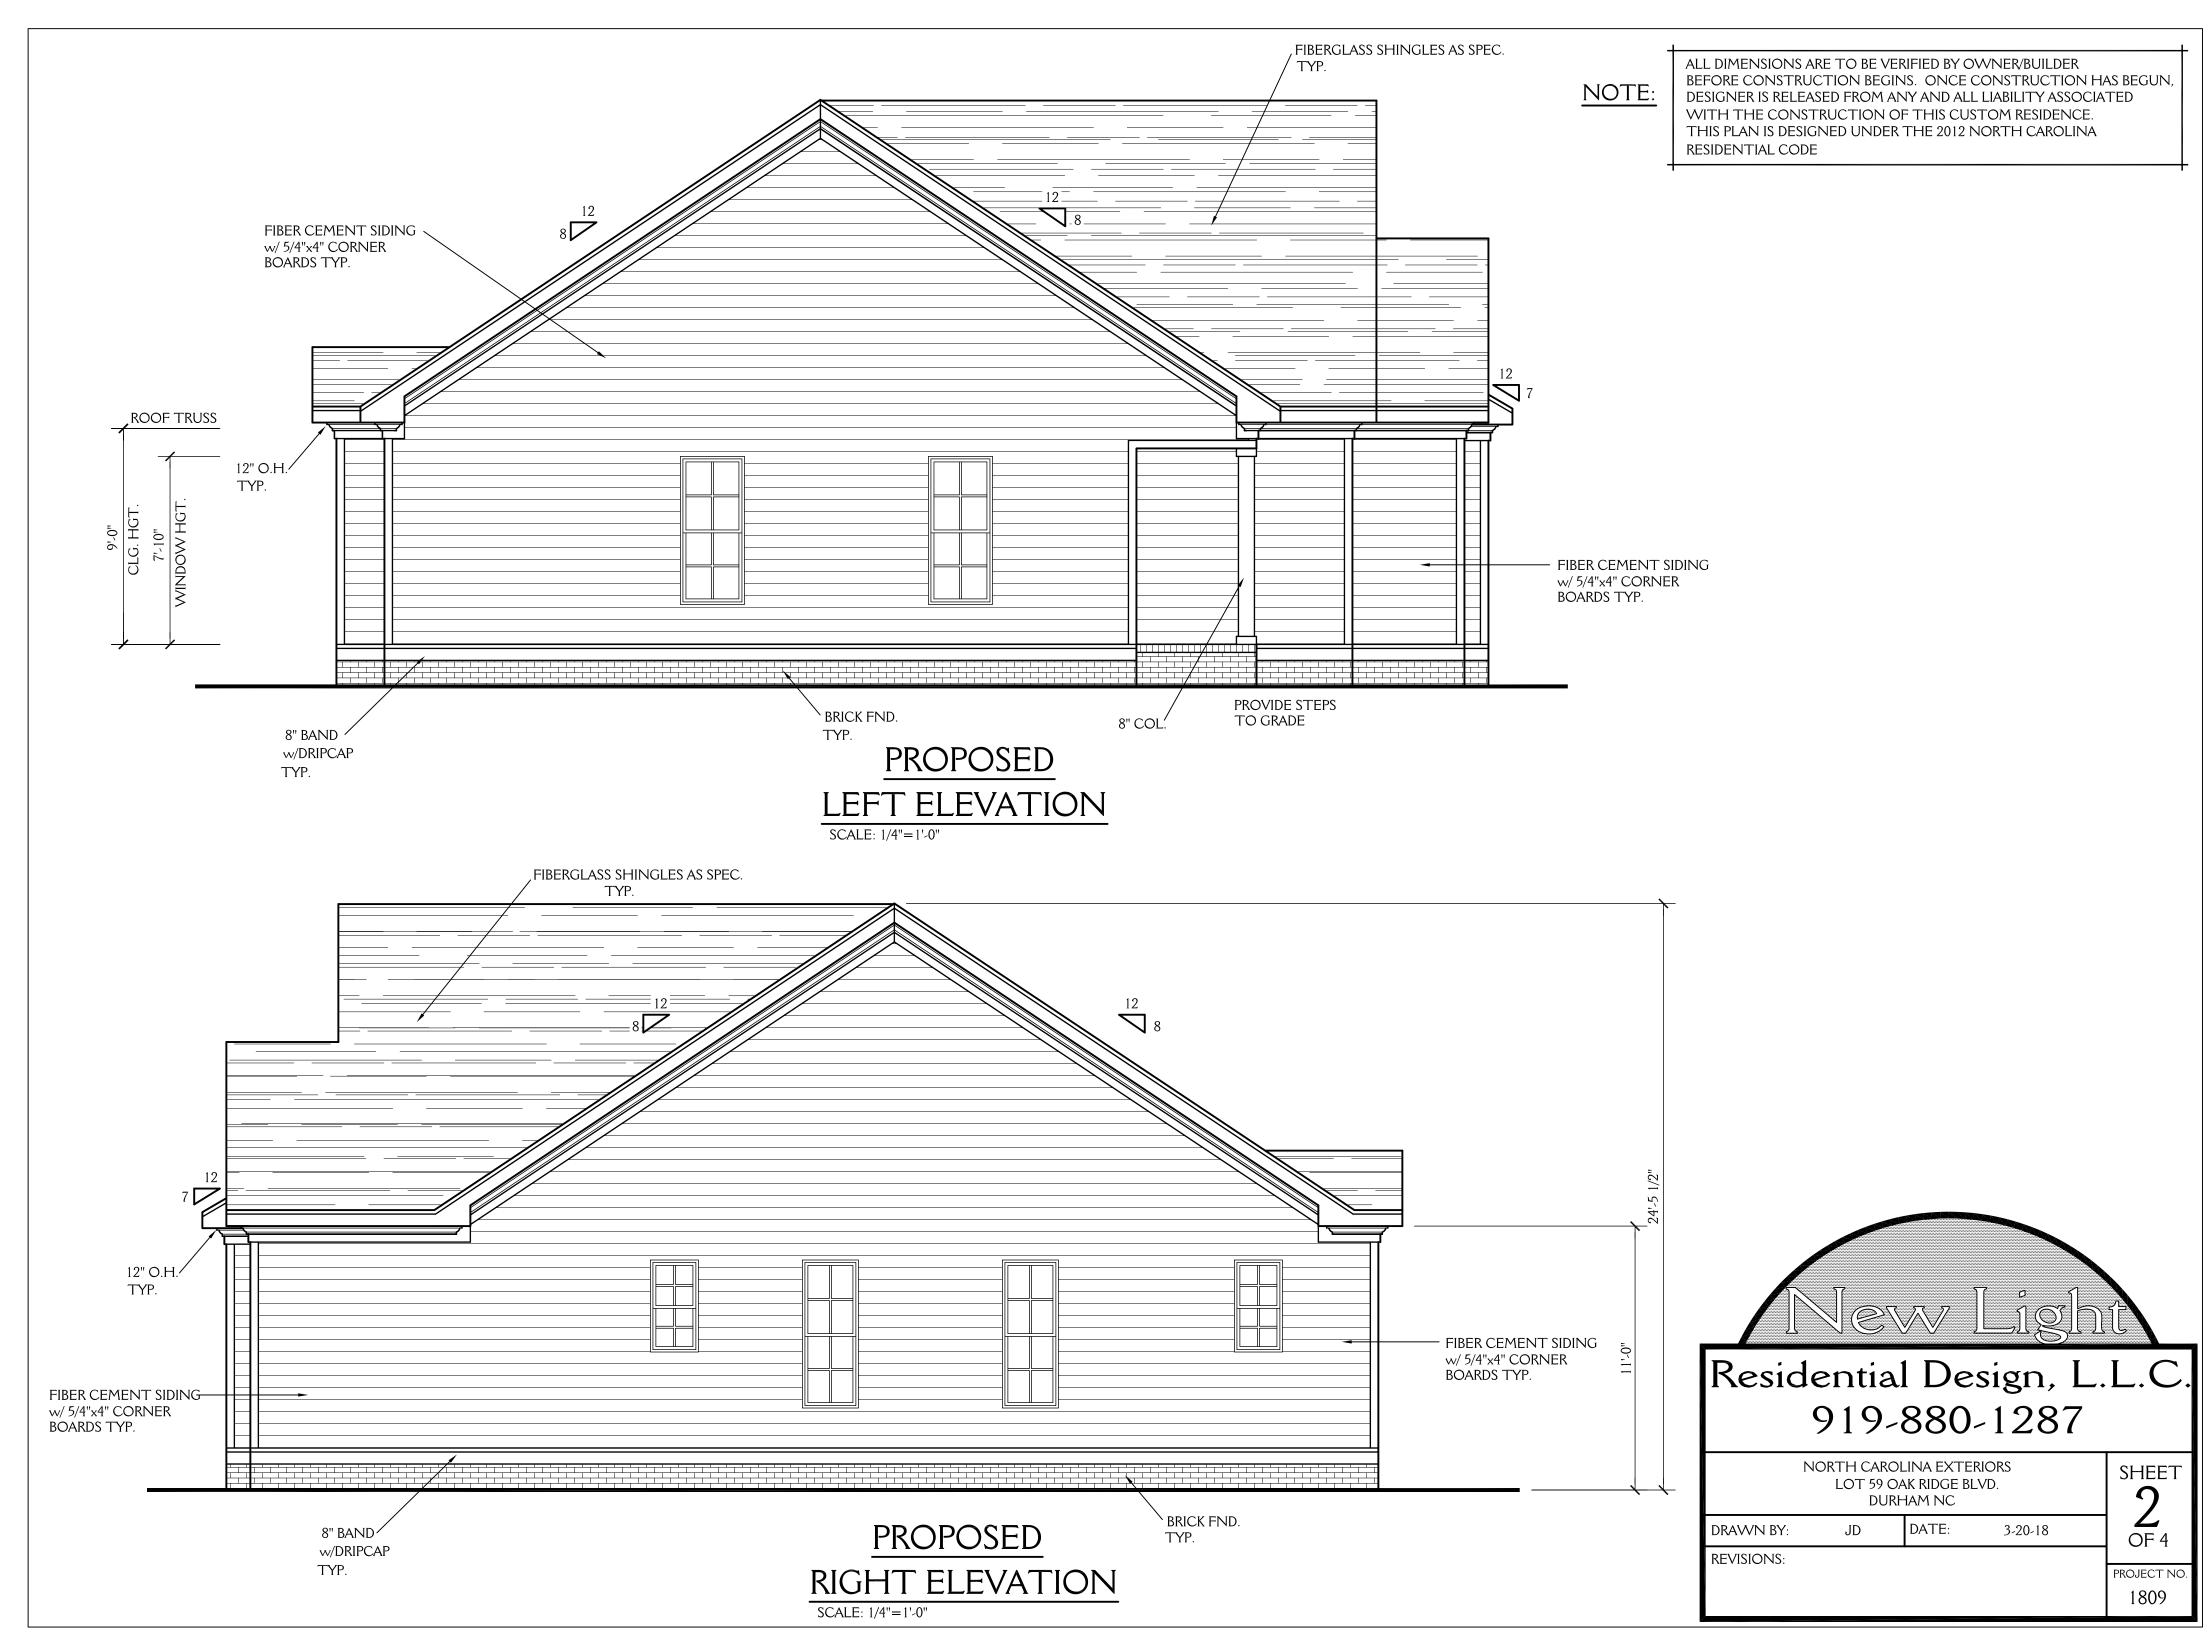

ALL DIMENSIONS ARE TO BE VERIFIED BY OWNER/BUILDER NOTE: WITH THE CONSTRUCTION OF THIS CUSTOM RESIDENCE. THIS PLAN IS DESIGNED UNDER THE 2012 NORTH CAROLINA RESIDENTIAL CODE

BEFORE CONSTRUCTION BEGINS. ONCE CONSTRUCTION HAS BEGUN, DESIGNER IS RELEASED FROM ANY AND ALL LIABILITY ASSOCIATED

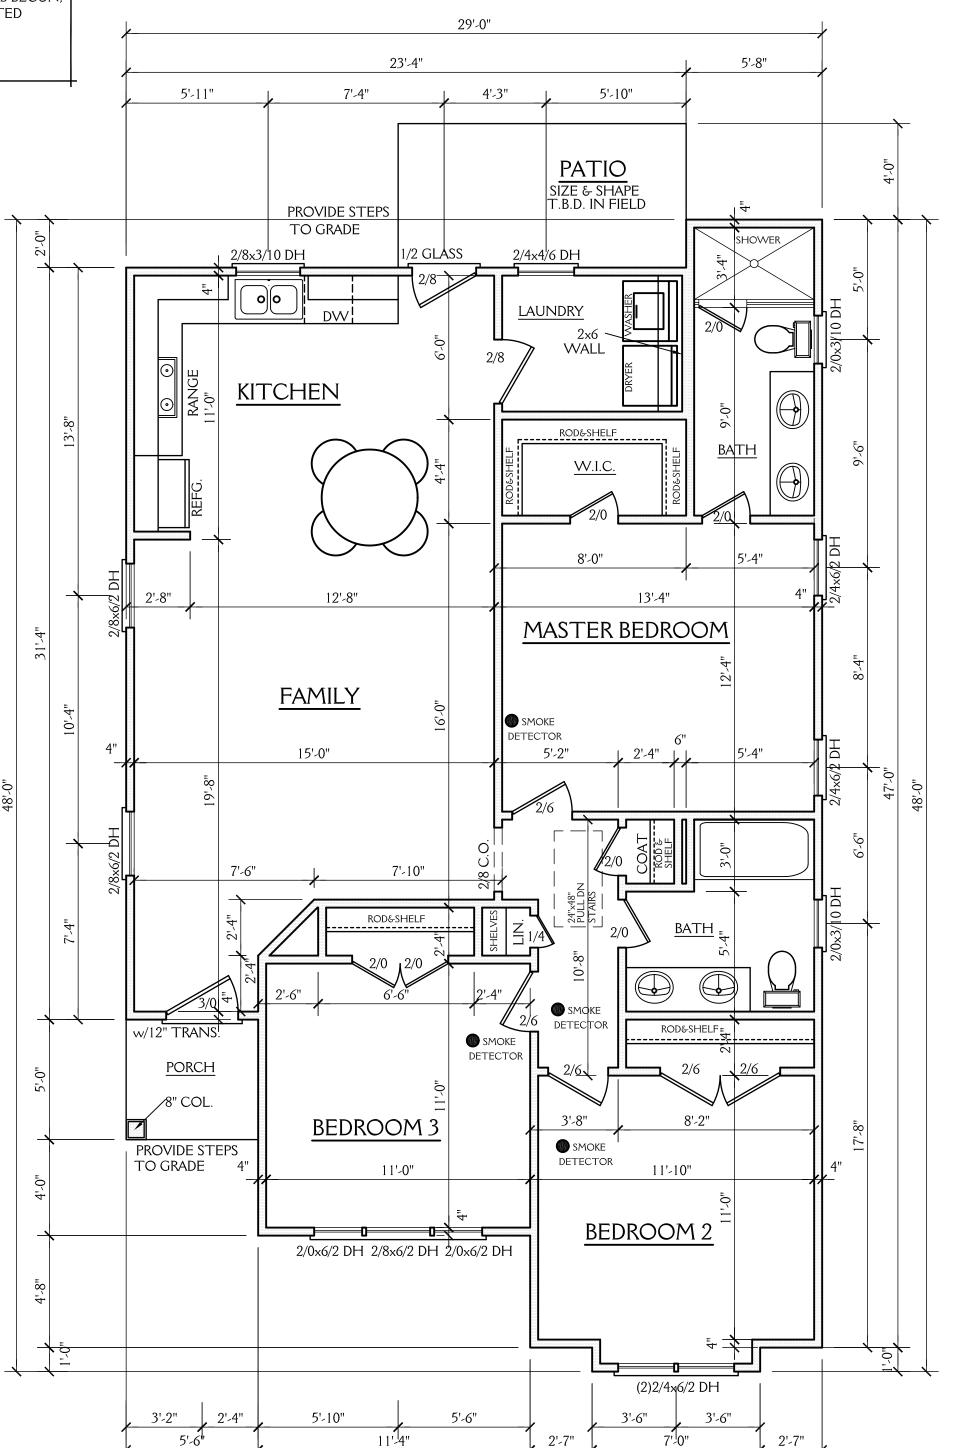

29'-0"

NOTES:

CONSTRUCTION TO MEET OR EXCEED ALL REQUIREMENTS OF THE 2012 NC RESIDENTIAL BUILDING CODE

- 1. SEE SECTION R310 OF THE 2012 NC RESIDENTIAL BUILDING CODE FOR ALL EMERGENCY ESCAPE & RESCUE OPENING REQUIREMENTS.
- 2. BUILDER & WINDOW SALESMAN TO CONFIRM THAT WINDOWS CHOSEN MEET ALL REQUIREMENTS OF SECTION R310 OF THE 2012 NC RESIDENTIAL BUILDING CODE.
- 3. SEE SECTION R308.4 OF THE 2012 NC RESIDENTIAL BLDG. CODE FOR GLAZING REQUIREMENTS IN HAZARDOUS LOCATIONS
- 4. PROVIDE FALL PROTECTION AT WINDOWS AS REQUIRED BY 2012 NC RESIDENTIAL BUILDING CODE
- 5. ALL GLASS TO HAVE A U FACTOR OF 0.35 OR LESS AND SHGC OF .30 OR MORE.
- 6. SEE CHAPTER 11 OF THE 2012 NC RESIDENTIAL BUILDING CODE FOR ALL ENERGY CONSERVATION REQUIREMENTS
- 7. SEE SECTION R302.6 OF THE 2012 NC RESIDENTIAL BLDG. CODE FOR DWELLING/ GARAGE FIRE SEPARATION REQUIREMENTS
- 8. SEE APPENDIX M OF THE 2012 NC RESIDENTIAL BUILDING CODE FOR ALL DECK CONSTRUCTION REQUIREMENTS
- 9. PROVIDE CARBON MONOXIDE DETECTORS AS PER SECTION R315 OF THE 2012 NC RESIDENTIAL **BUILDING CODE**

ABBREVIATIONS

C.O.: CASED OPENING D.W.: DISHWASHER W.I.C.: WALK IN CLOSET SHWR.: SHOWER DN.: DOWN TYP.: TYPICAL CLG.: CEILING HGT.: HEIGHT COL.: COLUMN TRANS.: TRANSOM

CANT.: CANTILEVER

1195 SQ FT HTD (1ST FLOOR) 1195 SQ FT HTD TOTAL

72 SQ FT (PATIO) 28 SQ FT (PORCH) 100 UNHEATED TOTAL

FIRST FLOOR PLAN


SCALE 1/4"=1'-0" 9'-0" CLG. HGT. SET WINDOWS AT 7'-10" AFF New Light Residential Design, L.L.C. 919-880-1287 NORTH CAROLINA EXTERIORS SHEET LOT 59 OAK RIDGE BLVD.


DURHAM NC DATE: JD DRAWN BY: 3-20-18 **REVISIONS:**

1809

OF 4


PROJECT NO.

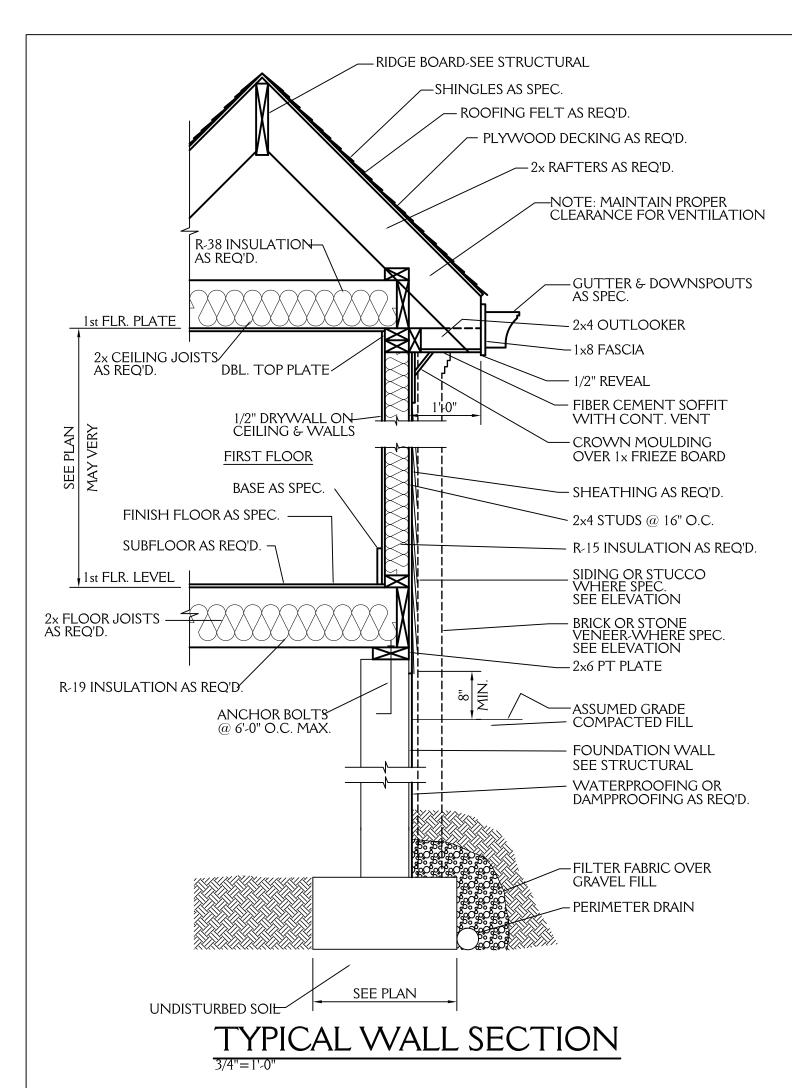

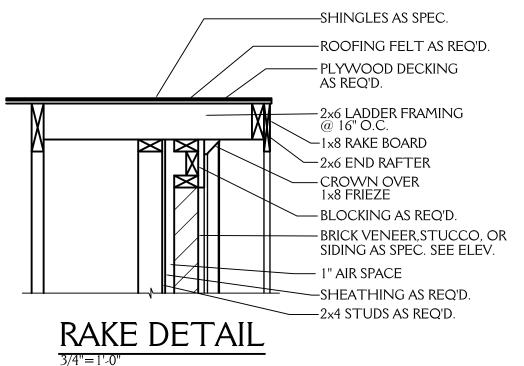


NOTE:


ALL DIMENSIONS ARE TO BE VERIFIED BY OWNER/BUILDER BEFORE CONSTRUCTION BEGINS. ONCE CONSTRUCTION HAS BEGUN, DESIGNER IS RELEASED FROM ANY AND ALL LIABILITY ASSOCIATED WITH THE CONSTRUCTION OF THIS CUSTOM RESIDENCE. THIS PLAN IS DESIGNED UNDER THE 2012 NORTH CAROLINA RESIDENTIAL CODE

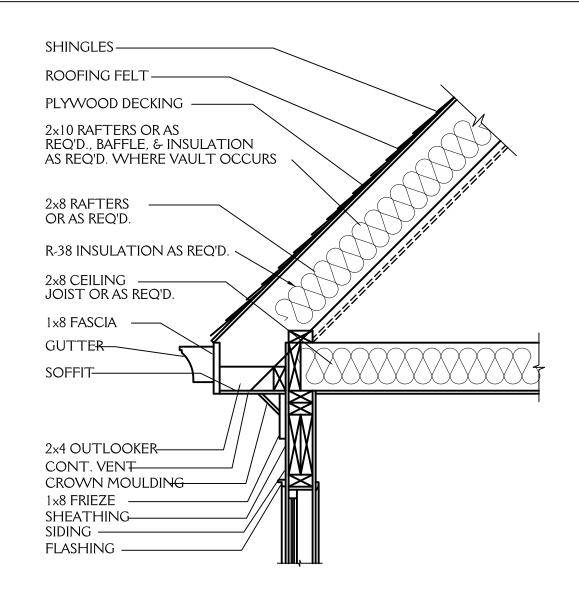



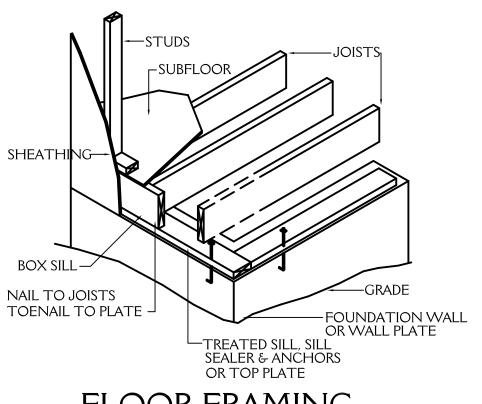

FLOOR FRAMING NTS

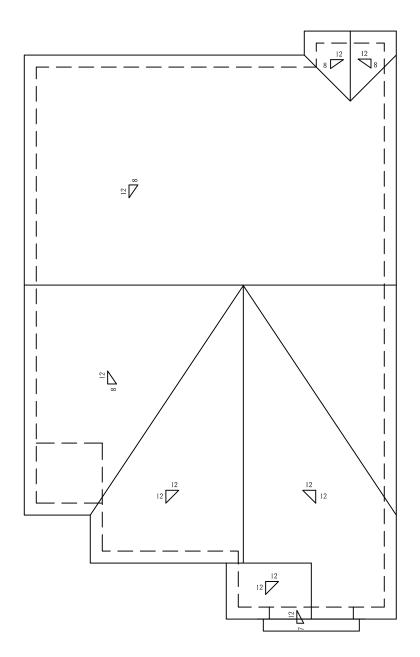

ROOF PLAN

SCALE 1/8"=1'-0"

ROOF VENT CALCS

1216 SQ.FT. / 150 = 8.11 SQ.FT. REQ'D

BUILDER TO PROVIDE APPROPRIATE VENTILATION AS REQUIRED BY CODE SEE SECTION R806 OF THE 2012 NC RESIDENTIAL BLDG. CODE

FND VENT CALCS

1094 SQ.FT. / 150 = 7.29 SQ.FT. REQ'D

BUILDER TO PROVIDE APPROPRIATE VENTILATION AS REQUIRED BY CODE SEE SECTION R408 OF

THE 2012 NC RESIDENTIAL BLDG. CODE

